
How do we achieve Net Zero within our church buildings? Some Do's and Don'ts



Grant Elliott, RIBA, CA

Le Page Architects

Introduction

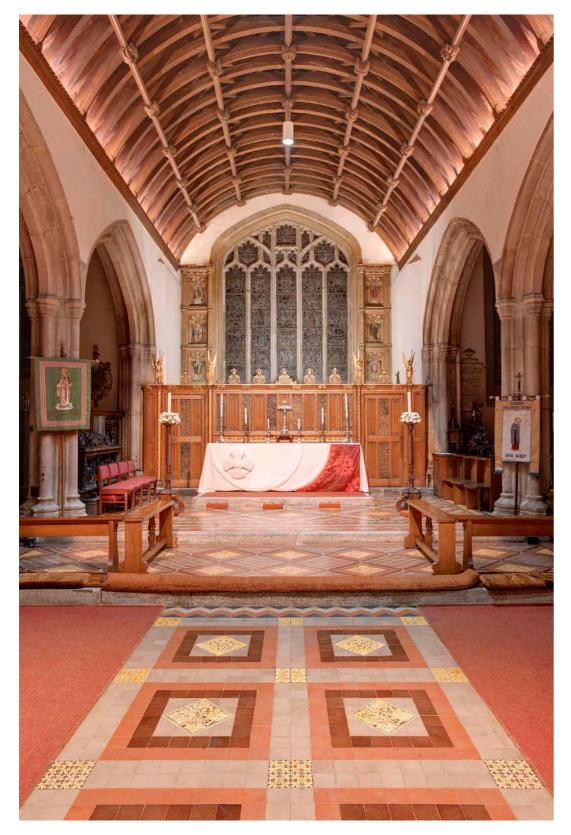






St Petroc, Bodmin – Light and Sound – *Le Page Architects*

Introduction

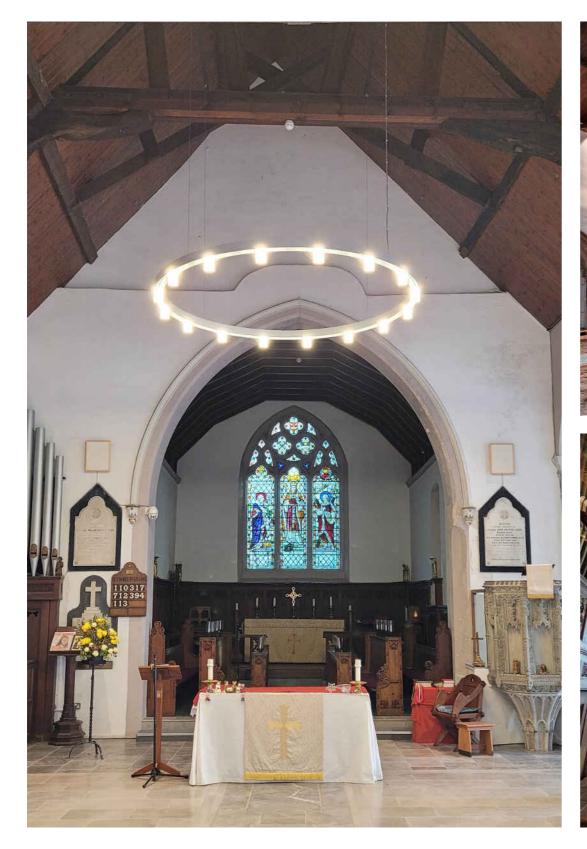






St Andrew with St Luke, Stoke Damerel, Plymouth – ReOrdering and Underfloor Heating – *Le Page Architects*

Introduction

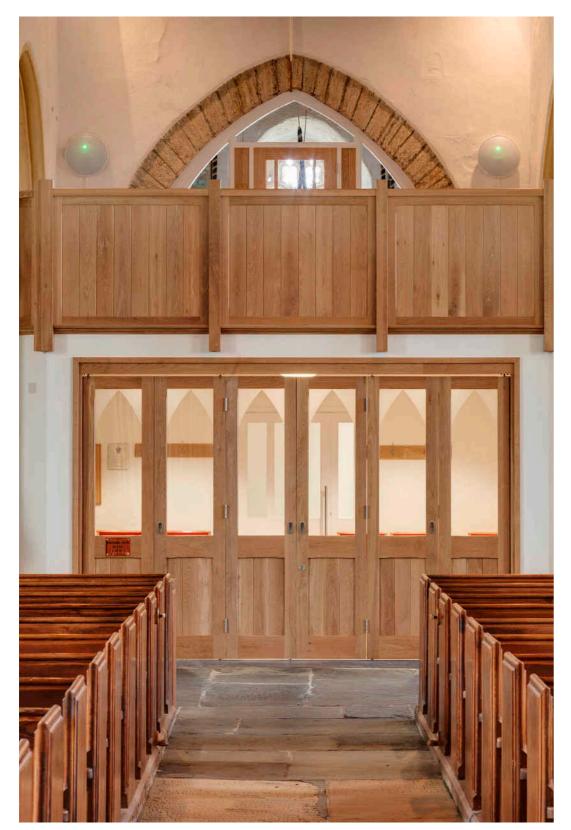







All Saints, Marlborough – Re Ordering – *Le Page Architects*

Zero Carbon & Key Principles

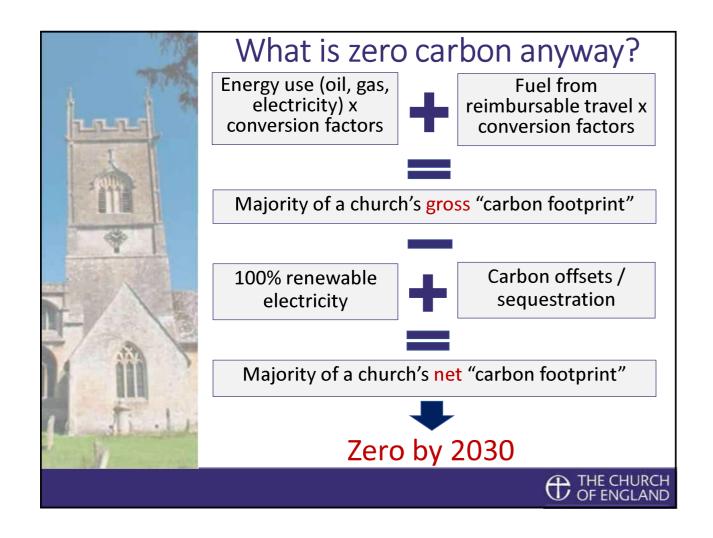


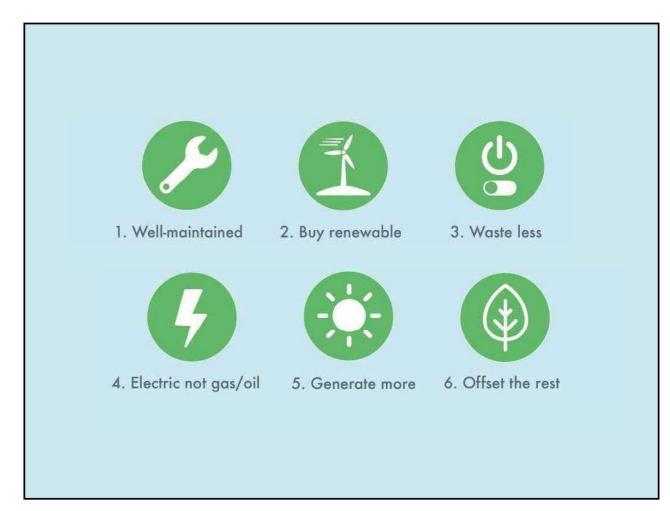


7% of churches are already net zero carbon Source: Catherine Ross, Church of England Environment Programme

Heating

Heating makes up the majority of church energy use, so it needs to be the focus for action. Larger, busier churches with the heating on for much of the week will have higher emissions and need different technical solutions.

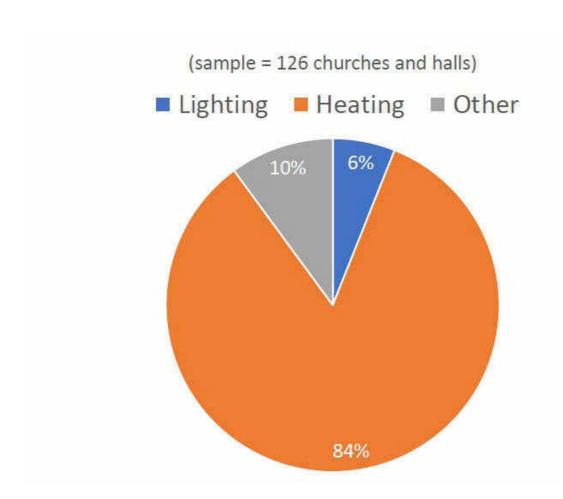



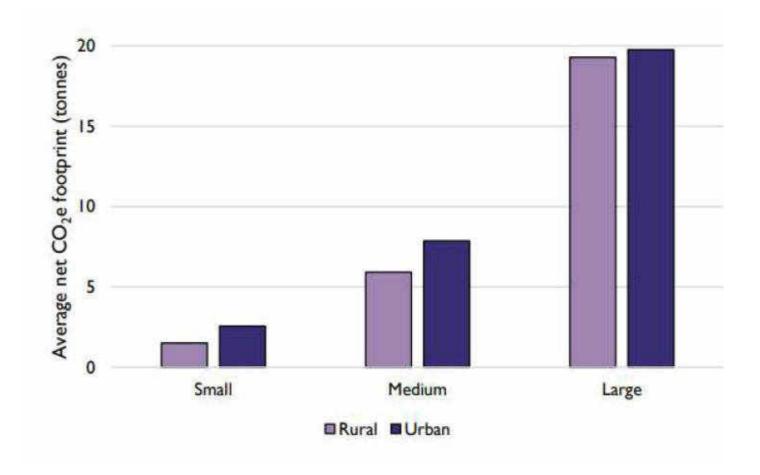

Quick Wins

Match heating timing to use

Turn off heating before end of service

Complete the Energy Footprint Tool each year and communicate the results

Create an energy champion to review use

Encourage people to turn things off

Move PCC meetings elsewhere during cold months

Install a smart meter

Vary service times in winter

Maintain the roof and gutters

Fix broken window panes

Insulate around heating pipes

Draught proof around gaps

As lights fail, replace with LED bulbs where suitable

Source: Catherine Ross, Church of England Environment Programme

Next Steps

Insulate easy to access lofts

Install a draught lobby

Use data loggers and smart meters

Improve zoning, install TRVs

Set boiler temperatures correctly

Install thermal or motion sensors

Replace gas / oil space heating with electric pew / panel heaters

Source: Catherine Ross, Church of England Environment Programme

Getting to Zero

Draught proofing to windows

Secondary / double glazing to suitable windows in busy areas, eg office / hall

Draft-proof the tower ceiling

Insulate under pew platforms

Internally insulate suitable areas

Reinstate ceilings where appropriate

New lighting systems

Solar PV panels

Source: Catherine Ross, Church of England Environment Programme

Only If

If re-roofing > insulate and solar?

If suitable and very busy > external renders

If used all week > heat pumps

If used all week and lifting the floor anyway > underfloor heating

If nothing else viable > new gas boiler

If lots of car use > EV charging points

Source: Catherine Ross, Church of England Environment Programme


Case Study 1, St Sampson, South Hill




St Sampson, South Hill

St Sampson, Repairs



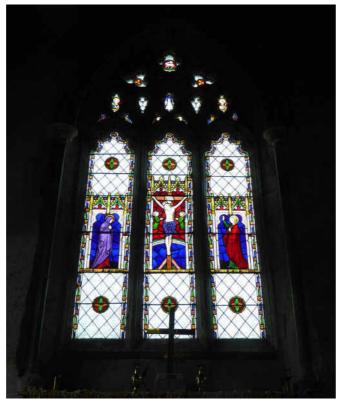



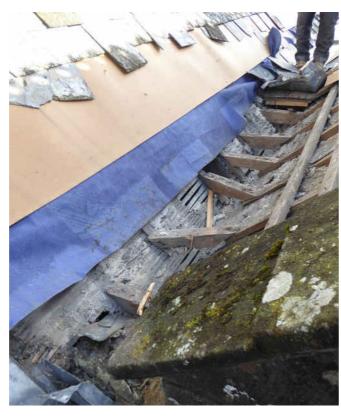

replacement is required. Their life could be prolonged by removing and decorating them with a suitable paint system.

Condition summary:

- There has been some structural movement, as evidenced by the crack to the stone sill of b-light, which has caused the glazing to spread, pulling away the s perimeter lead and causing the panel to separate on the s side of Christ's body (RH image below).
- The ferrous bars are rusting and loose at the tips to panel 2b.
- At second row of bars, ties are situated above the inscriptions which is encouraging the panels to fold inward at that line.
- The ribbon pointing is failing at the jambs.
- Panel 2b is especially flexible and has insufficient ties.
- Localised but quite severe paint-loss to Christ's face (LH image below), Mary's face, the pelican.
- Several open joints externally at the tracery, numerous mortar repairs.
- One piece of tracery stone has de-laminated externally, though this is not a structural problem.
- The division leads are in poor condition.






Recommendations:

High Priority

- Remove b-light and 1a and 1c. Board openings. Take careful stone measurements.
- Stone mason to remove external guards, rake out defective mortar and re-point tracery.
- Rub down and decorate wire guards using suitable paint system.
- Re-align leading where panel has spread, allow to re-lead locally if necessary.

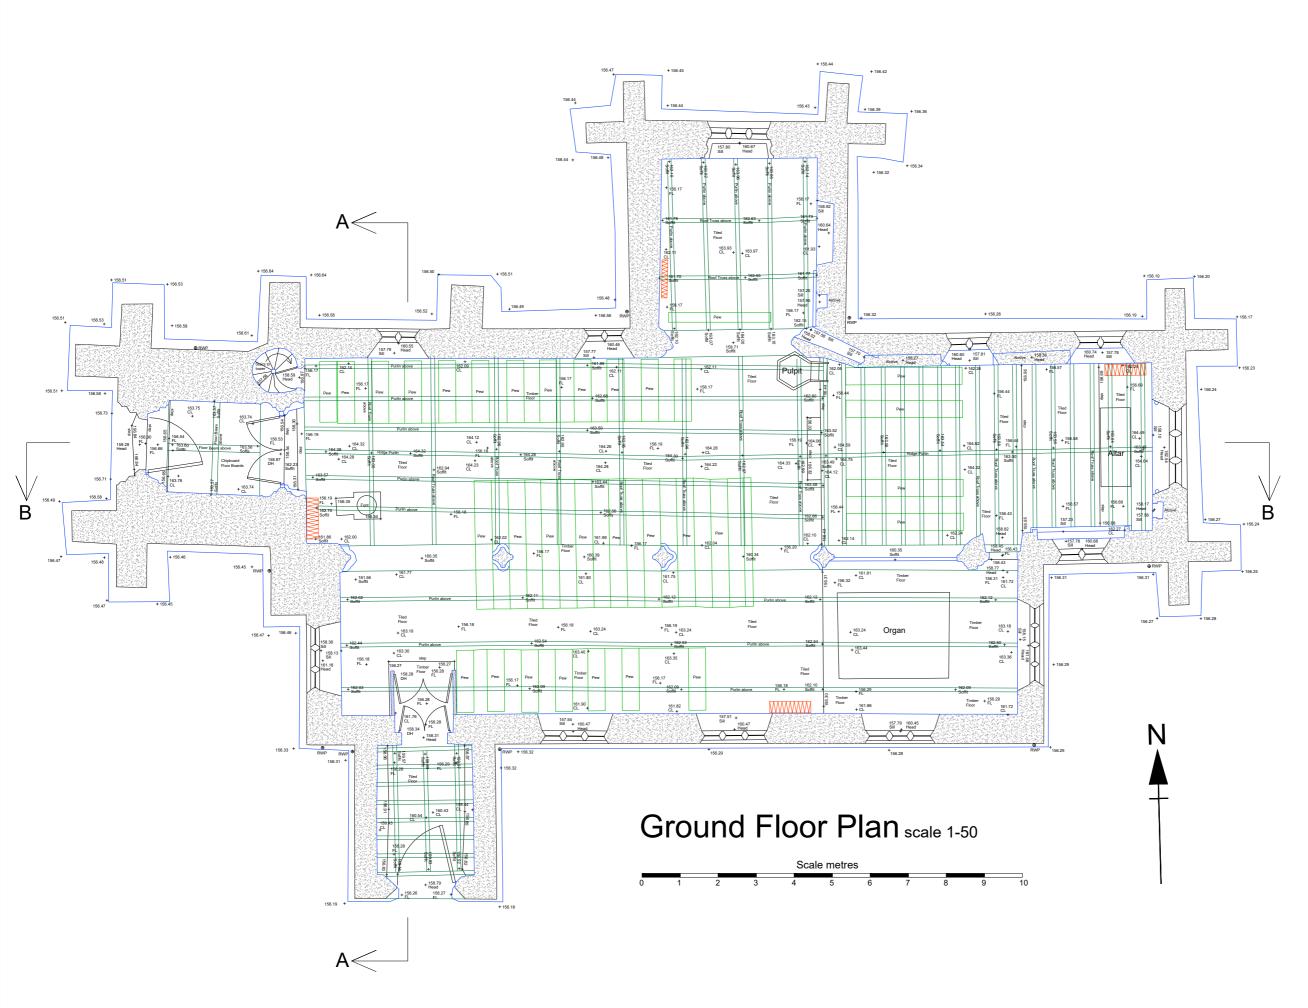


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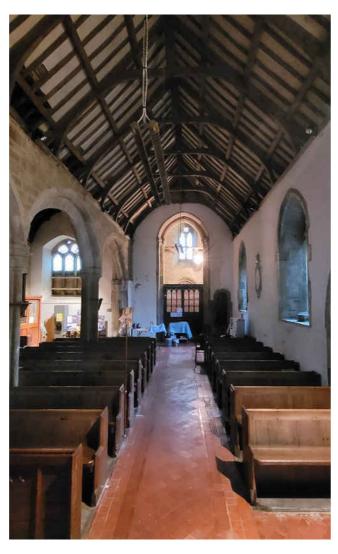
PCC St Sampson's, South Hill Existing Ground Floor Survey Plan

1:50 @ A1 Date July 2019 Date JP/MS Checked by


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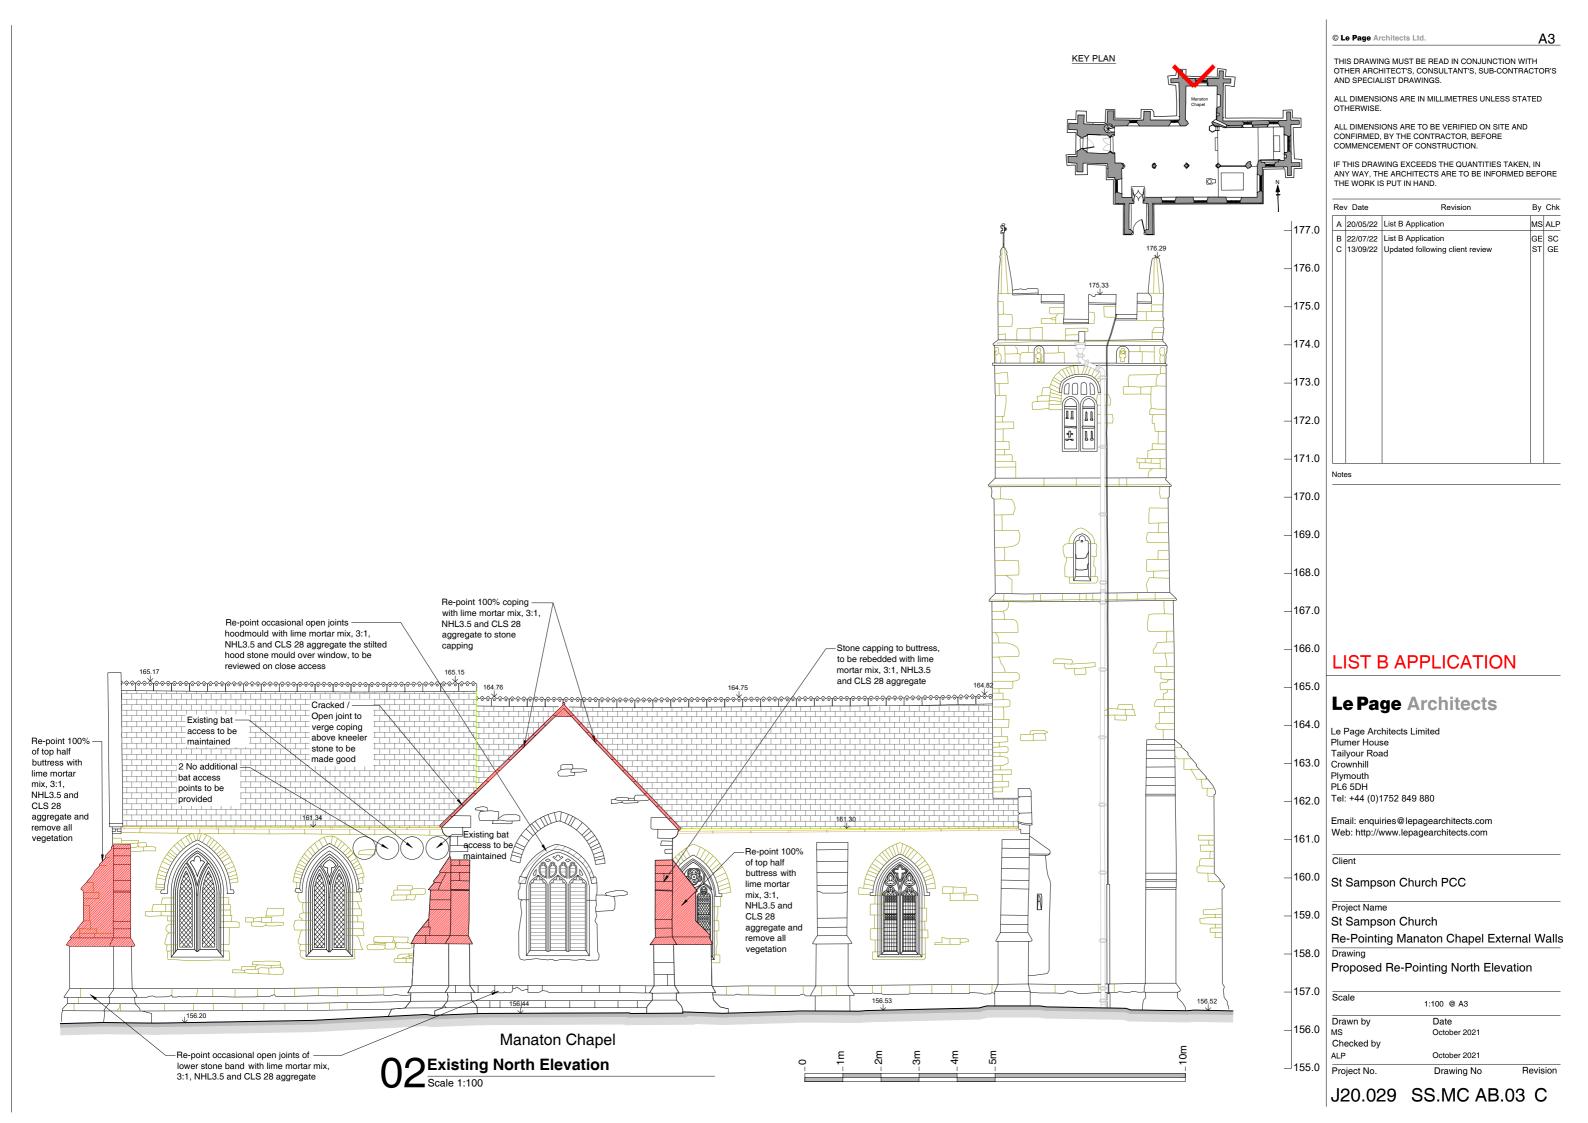







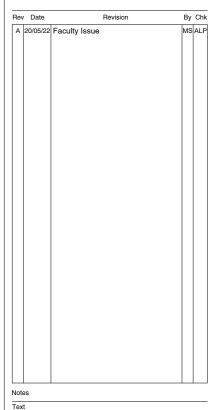



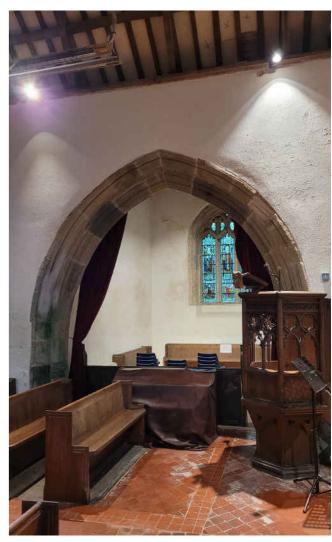

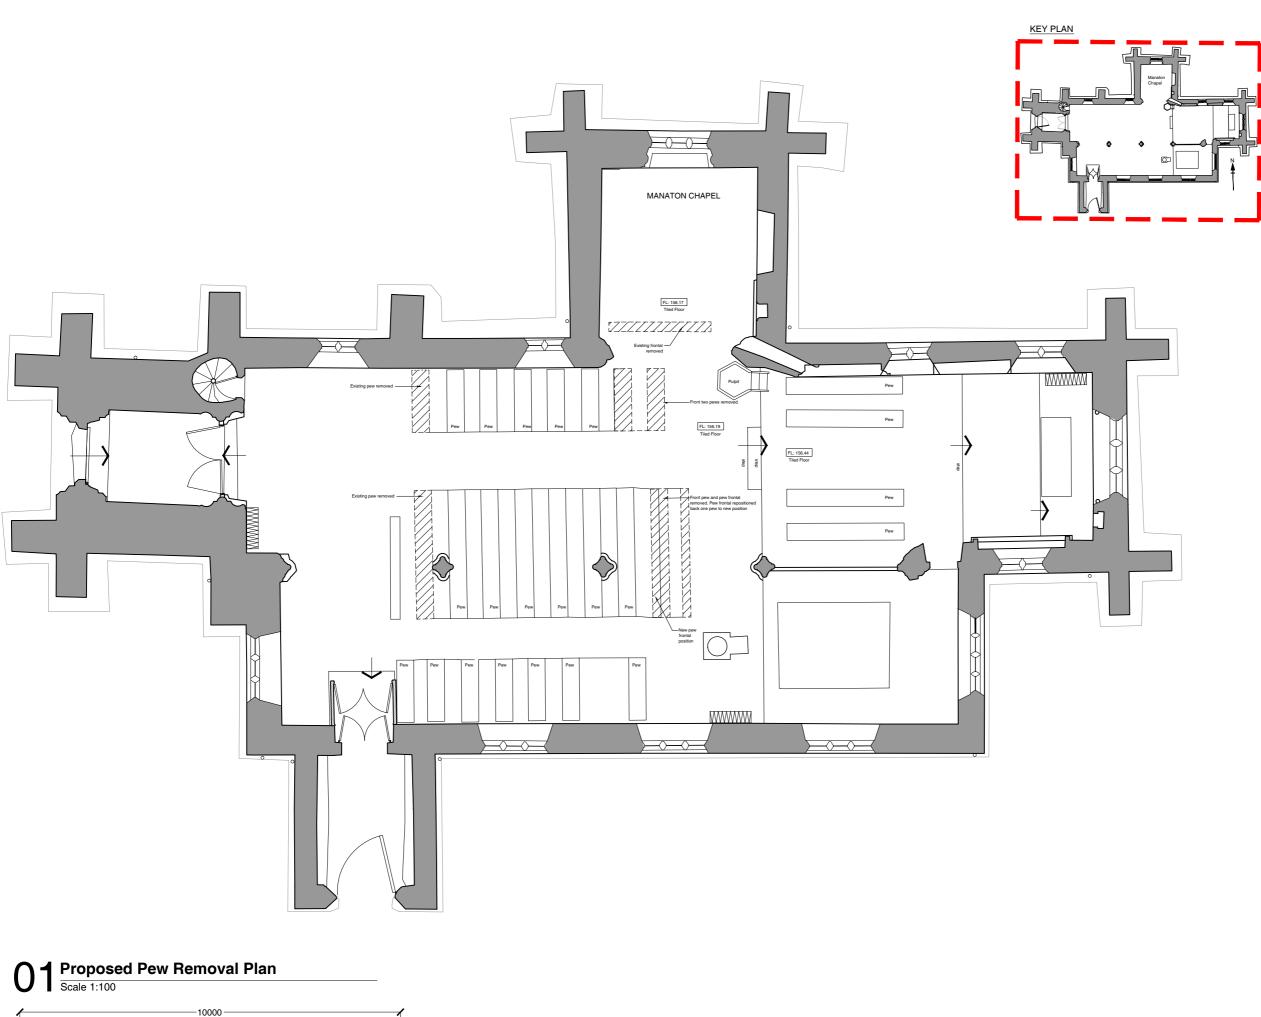

1000 1

5m

10m

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A	29/07/22	Updated following client review	GE S
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Client

St Sampson PCC

Project Name

St Sampson Church, Re-Order


Acces.WC, Kitchenette, Screen, Chapel

Drawing

Proposed Pew Removal Plan

Project No.	Drawing No	Revision
SC	Jul 2021	
Checked by		
GE	Jul 2021	
Drawn by	Date	
Scale	1:100 @ A3	

J20.029 SS.MC AB.52 A

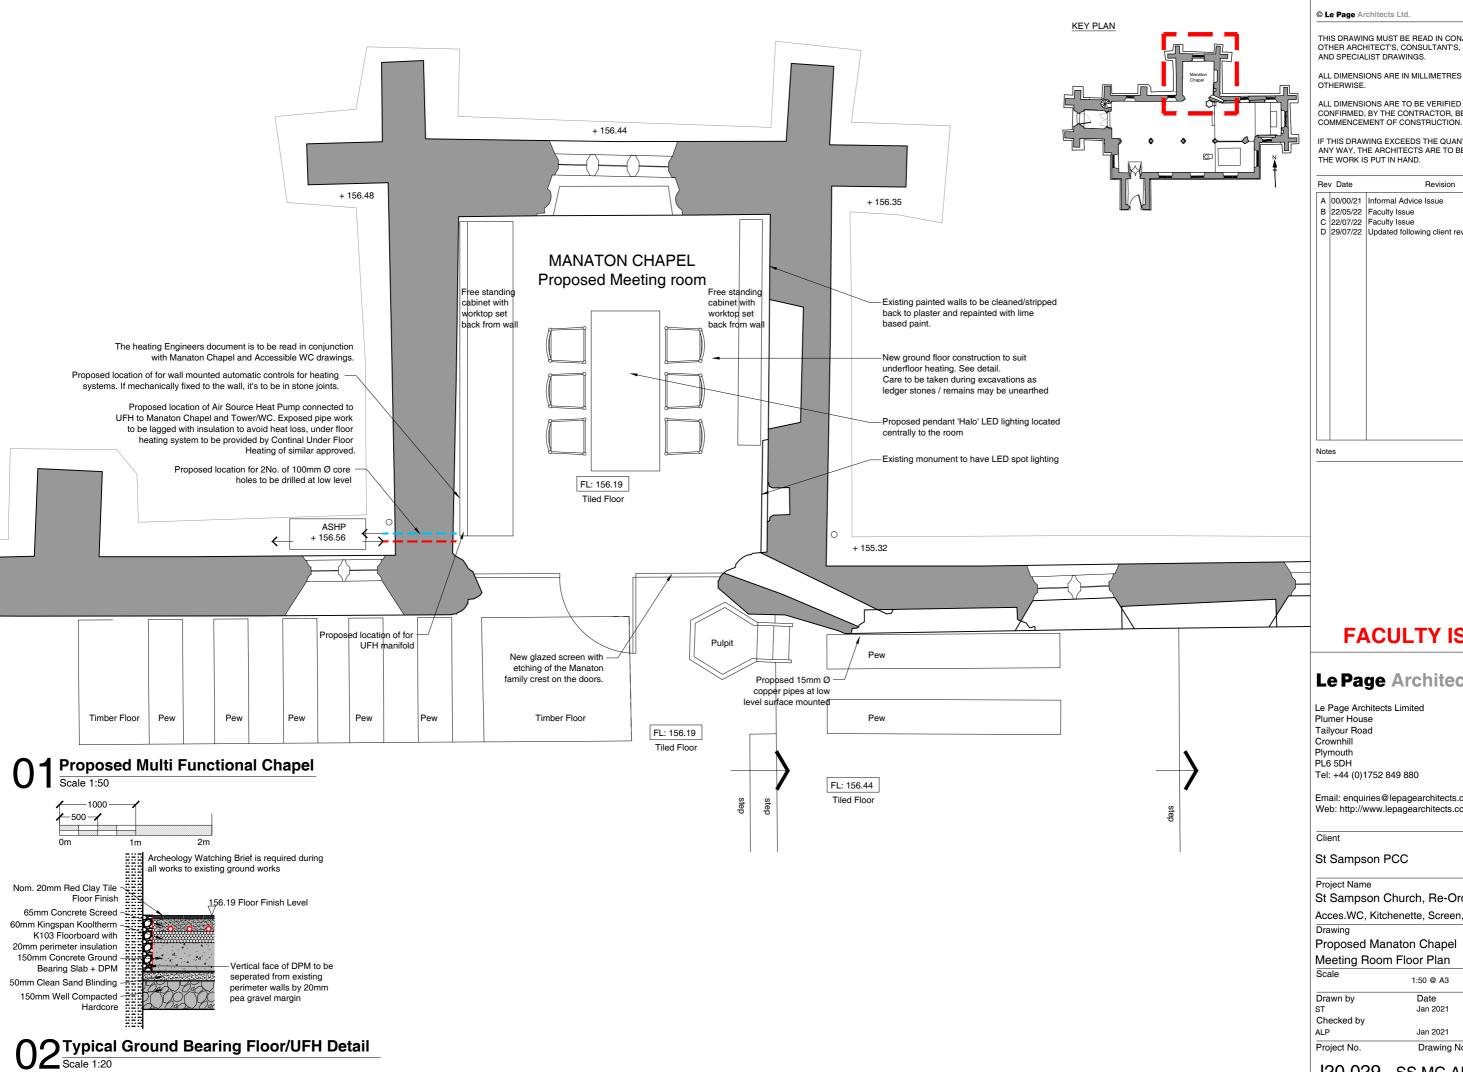

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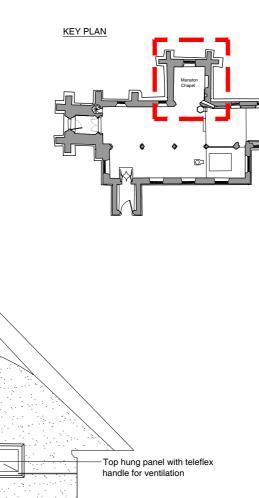
St Sampson Church, Re-Order


Acces.WC, Kitchenette, Screen, Chapel

Proposed Manaton Chapel

1:50 @ A3 Date Jan 2021 Jan 2021 Drawing No

J20.029 SS.MC.AB.50



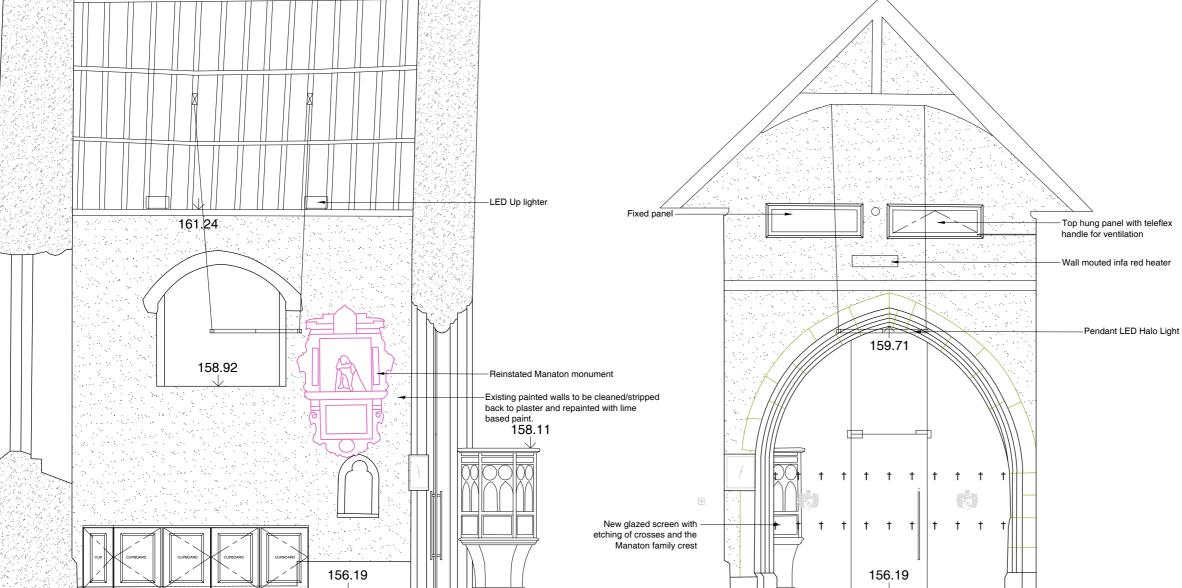

Proposed East Elevation

∠500 **∠**

Proposed South Elevation
Scale 1:50

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		Faculty Issue Updated following client review	GE GE	SC
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Client

St Sampson PCC

Project Name

St Sampson Church, Re-Order

Acces.WC, Kitchenette, Screen, Chapel


Drawing

Proposed Manaton Chapel

Internal Elevations, Sheet 1

Scale 1:50 @ A3 Drawn by Date Jul 2022 Checked by Jul 2022 Project No. Drawing No Revision

J20.029 SS.MC AB.53

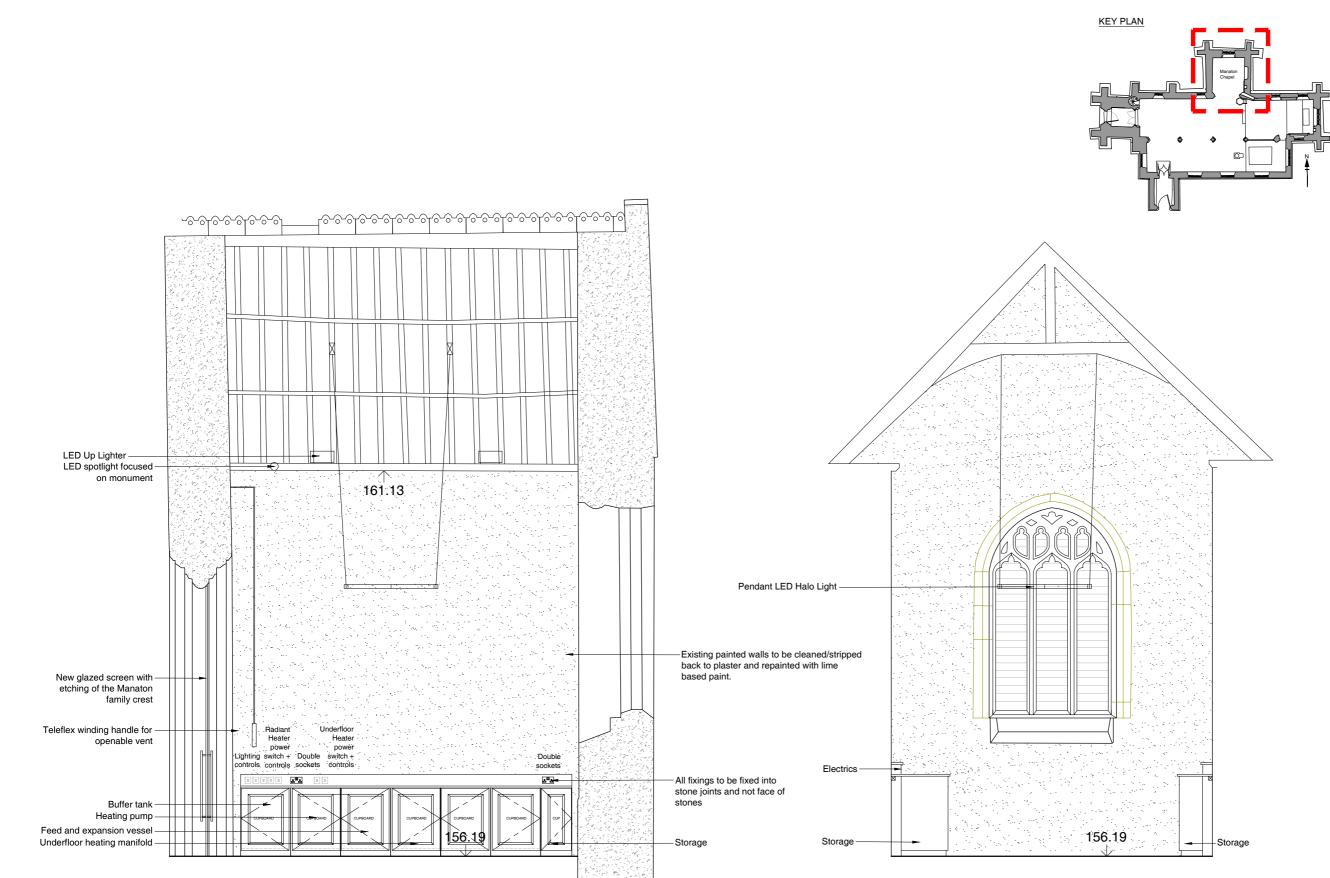

Proposed West Elevation

←500 **→**

Proposed North Elevation
Scale 1:50

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Client

St Sampson PCC

Project Name

St Sampson Church, Re-Order

Acces.WC, Kitchenette, Screen, Chapel


Drawing

Proposed Manaton Chapel

Internal Elevations, Sheet 2

Scale 1:50 @ A3 Drawn by Date Jul 2022 Checked by Jul 2022 Project No. Drawing No Revision

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OTHER ARCHITECT'S, CONSULTANT'S, SUB-CONTRACTOR'S
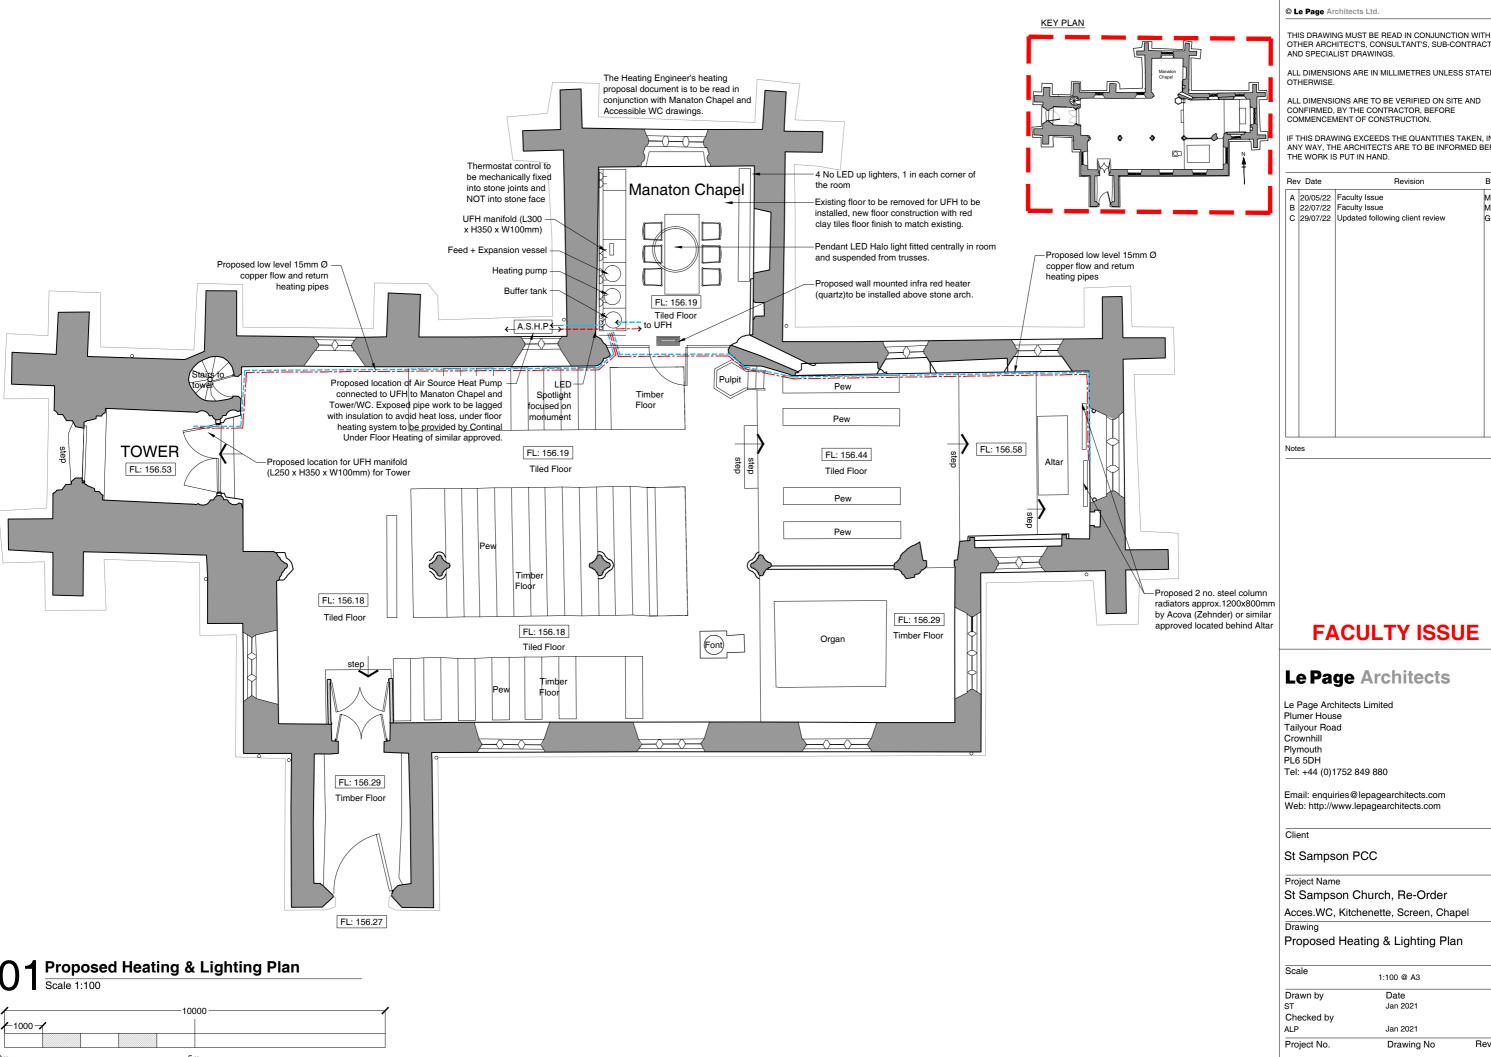
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St Sampson Church, Re-Order

Acces.WC, Kitchenette, Screen, Chapel

Proposed Heating & Lighting Plan

Scale	1:100 @ A3	
Drawn by	Date	
ST	Jan 2021	
Checked by		
ALP	Jan 2021	
Project No.	Drawing No	Revision

J20.029 SS.MC AB.51 C

Cornwall Council

Correspondence Address: Cornwall Council Planning, PO Box 676, Threemilestone,

Truro, TR1 9EQ

Email: planning@cornwall.gov.uk

Tel: 0300 1234151 Web: www.cornwall.gov.uk



Application number: PA22/10123

Agent: Applicant:

Mr Grant Elliott Mrs Miranda Lawrence-Owen

Le Page Architects Ltd
Pillarsalders
Plumer House
Trevigro
Tailyour Road
Plymouth
PL17 7JS

PL6 5DH United Kingdom

Town And Country Planning Act 1990 (As Amended)
Town And Country Planning (Development Management Procedure) (England)
Order 2015

Grant of Conditional Planning Permission

CORNWALL COUNCIL, being the Local Planning Authority, **HEREBY GRANTS CONDITIONAL PERMISSION**, subject to the conditions set out on the attached schedule, for the development proposed in the following application received on 11 November 2022 and accompanying plan(s):

Description of Development: Installation of air source heat pump

Location of Development: St Sampsons Church South Hill Callington Cornwall PL17

7LP

Parish: South Hill

DATED: 18 January 2023

ACFIII 7

YOUR ATTENTION IS DRAWN TO THE ATTACHED NOTES.

Louise Wood - Service Director Planning and Housing (Chief Planner Officer)

Conservation of Habitats and Species Regulations 2017 (as amended)

LICENCE – Mitigation



This licence authorises acts that would otherwise be offences under the above legislation

Any request for information in this licence will be considered under the Freedom of Information Act 2000 as appropriate.

Wildlife Licensing Service Natural England Horizon House Deanery Road Bristol BS1 5AH Tel: 0208 026 1089

Email: wildlife@naturalengland.org.uk

Licence number: 2021-54322-EPS-MIT-1

Under the Conservation of Habitats and Species Regulations 2017 (as amended) Natural England has granted this licence for Bat for the purpose of:

Imperative reasons of overriding public interest including those of a social or economic nature and beneficial consequences of primary importance for the environment under section 55(2)(e)

Name (in full)

Address

Southview Barn

83 Launceston Road

Callington

Cornwall

PL17 8DS

Project description:

Licensable activities associated with development works consented under reference number 2020-055036 & 2020-051504.


Between the dates of: 07/04/2022 and 01/10/2027

inclusive, subject to the conditions specified.


At locations:

Site/Location Name	County	OS Grid Reference
St Sampson's Church	Cornwall	SX329726


WML-L13 (02/2022) Natural England Ref: 2021-54322-EPS-MIT-1

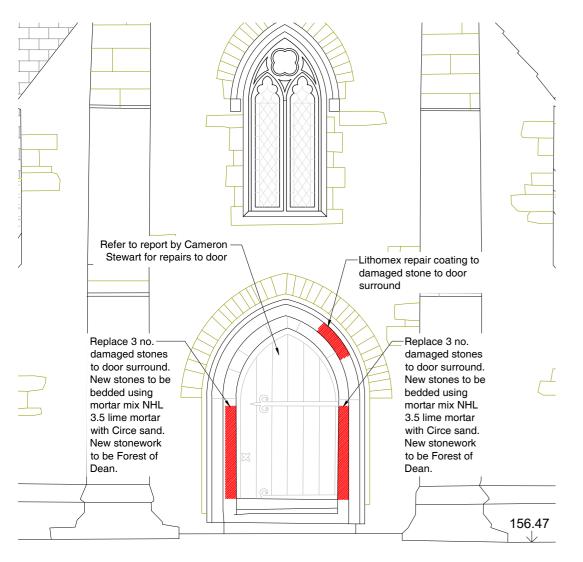

Existing External West Door Elevation

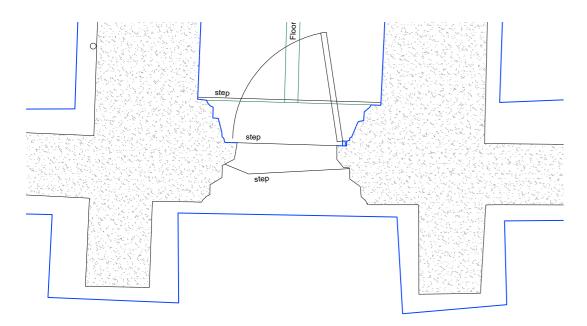

2 Existing External West Door Plan Scale 1:50

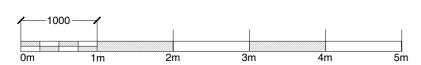



03 Existing External West Door Image Scale 1:50



04 Existing Internal West Door Elevation Scale 1:50

Remove cement render hoodmould. Replace with lime mortar hoodmould built out from stainless steel mesh screwed back to stonework with stainless steel screws. Finish with Lithomex repair coating.

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Client

St Sampson PCC

Project Nam

St Sampson Church Re-Ordering

Accessible WC, Timber Screen, Kitchenette Drawing


West Door and Stone Arch Refurbishment


Plan. Elevations & Images

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Scale	1:50 @ A3						
Drawn by	Date						
MS	August 2022						
Checked by							
GE	August 2022						
Project No	Drawing No	Revision					

J20.038

SS.WD.AB300 -

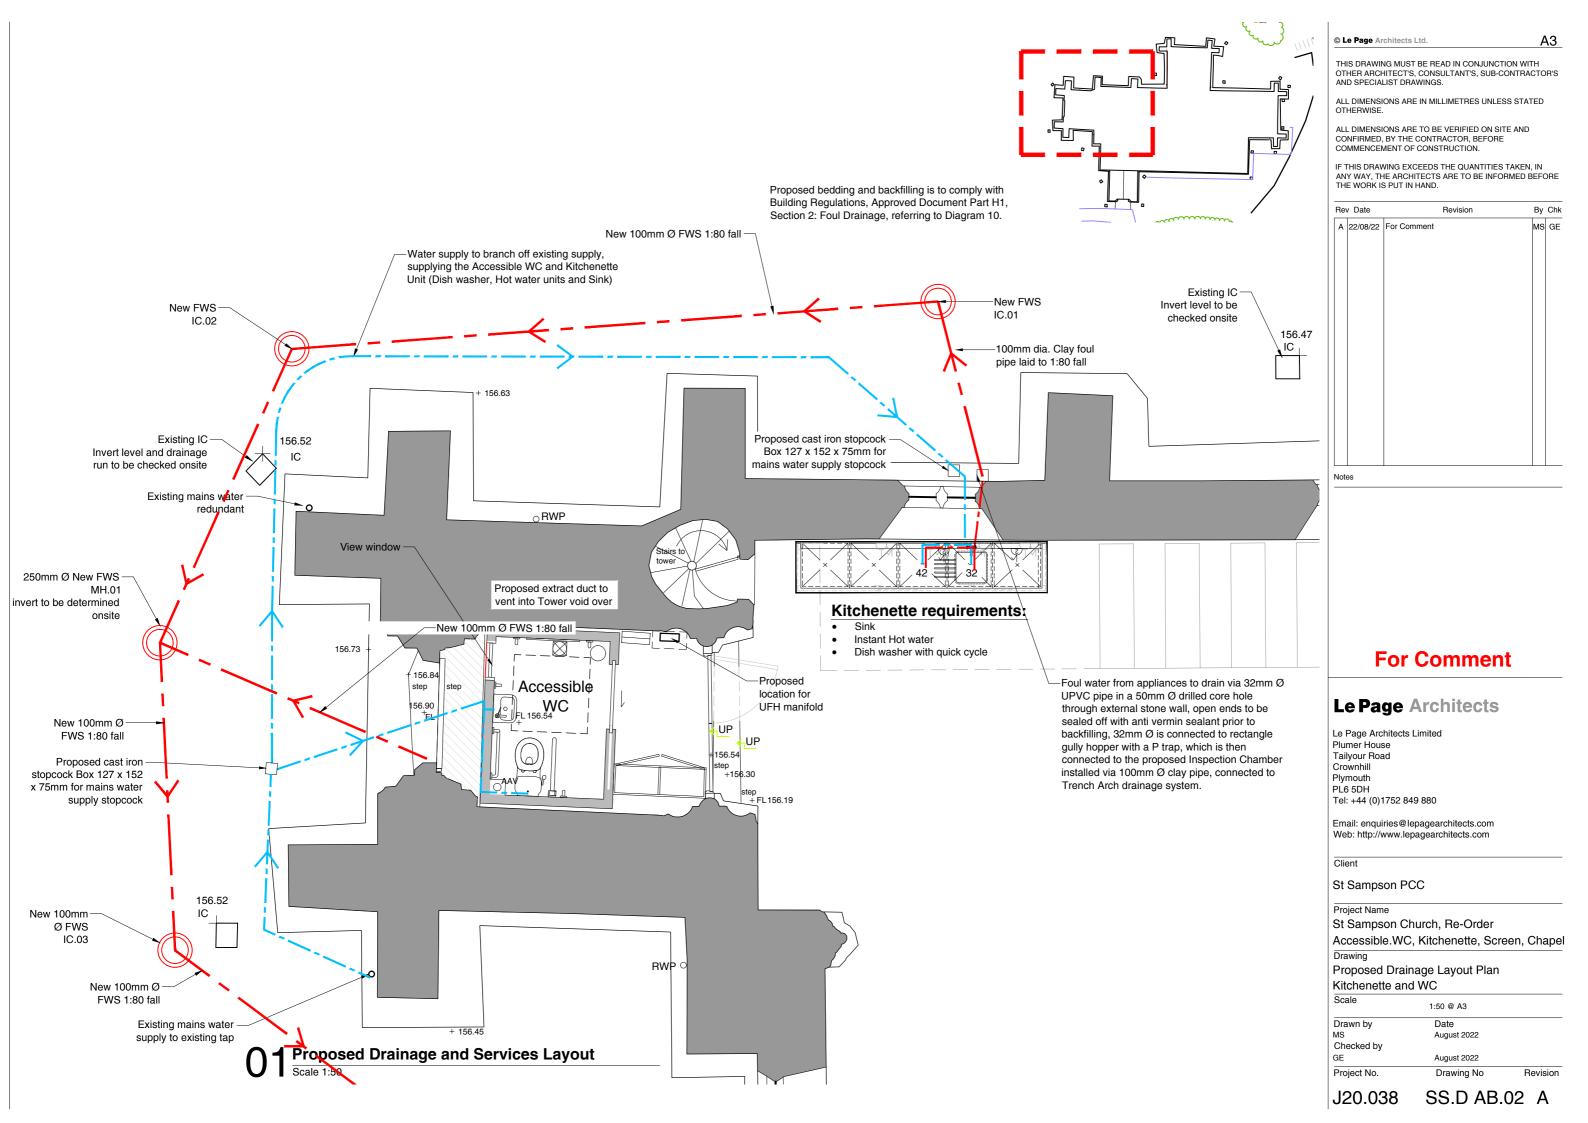

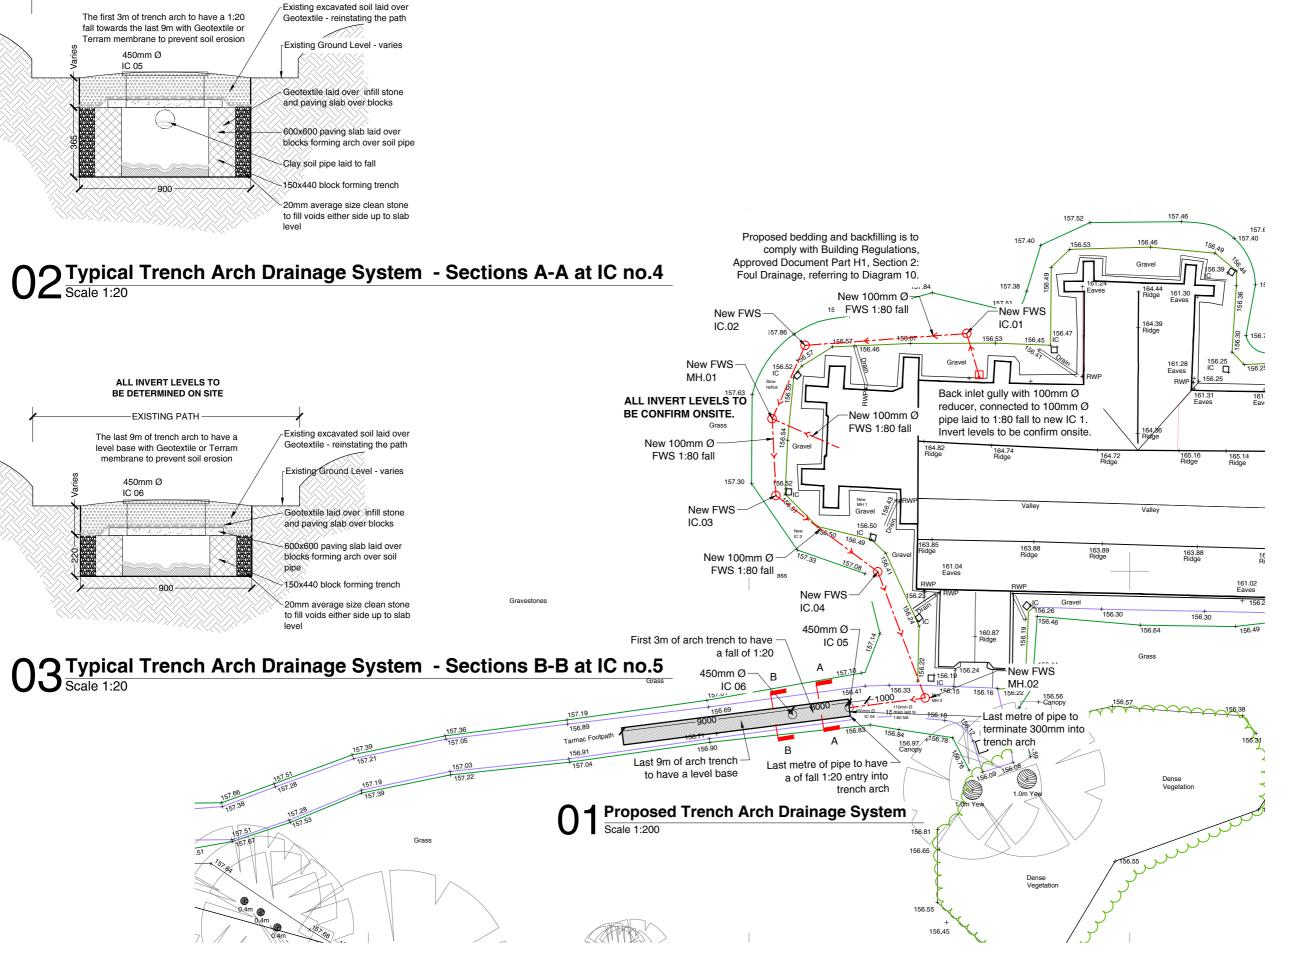

EXISTING PATH


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St Sampson PCC

Project Name


St Sampson Church, Re-Order


Accessible.WC, Kitchenette, Screen, Chapel

Proposed Drainage Layout Plan Trench Arch Foul Drainage System

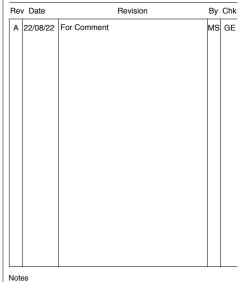
1:200 @ A3 Drawn by August 2022 Checked by August 2022 Project No. Drawing No

SS.D AB.01 A J20.038

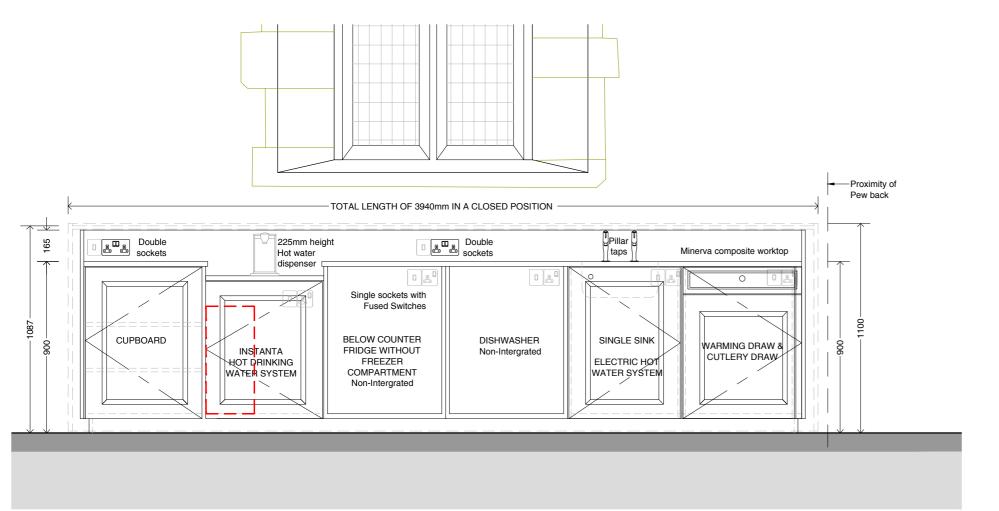

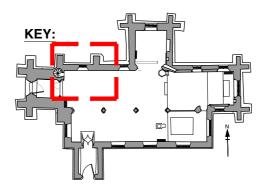

Proposed Hideaway Kitchenette in Elevation Scale 1:20

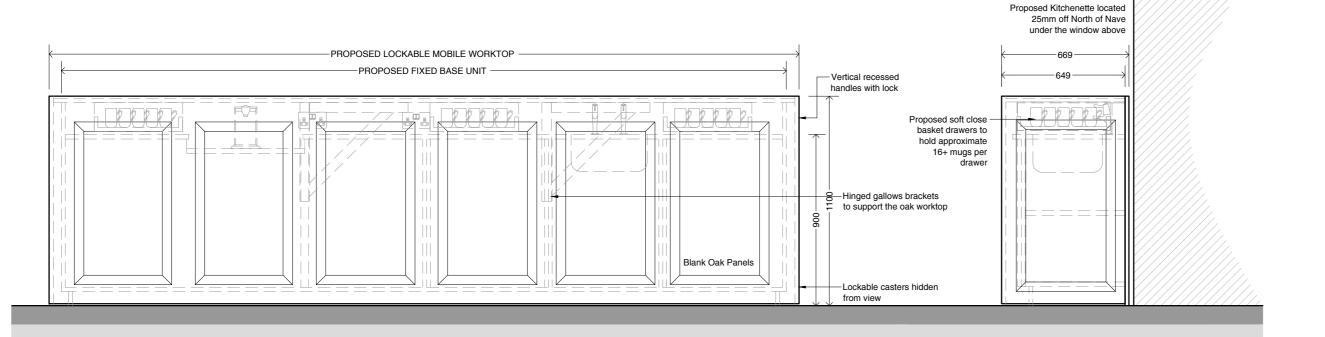

Proposed Hideaway Kitchenette Elevation in Closed Position

| Scale 1:20 |

Proposed Hideaway Kitchenette Side Elevation

Scale 1:20

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.

Joinery:

Joiner to provide shop drawings for CA approval prior to fabrication.

For Comment

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Client

St Sampson PCC

Project Name

St Sampson Church Re-Ordering

Acces.WC, Screen, Kitchenette, Chapel

Drawing

Proposed Hideaway Kitchenette

Proposed Elevations

Scale

1:20 @ A3

Drawn by

MS

August 2022

Checked by

GE


August 2022

Project No.


Drawing No

Revision

J20.038 SS.K AB101

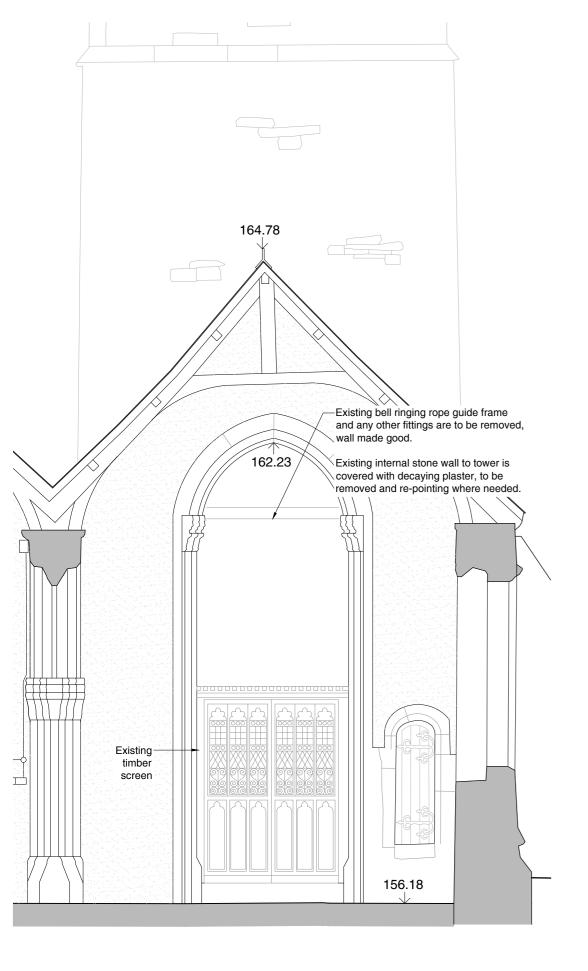

O 1 Existing Timber-Glass Screen Scale 1:50

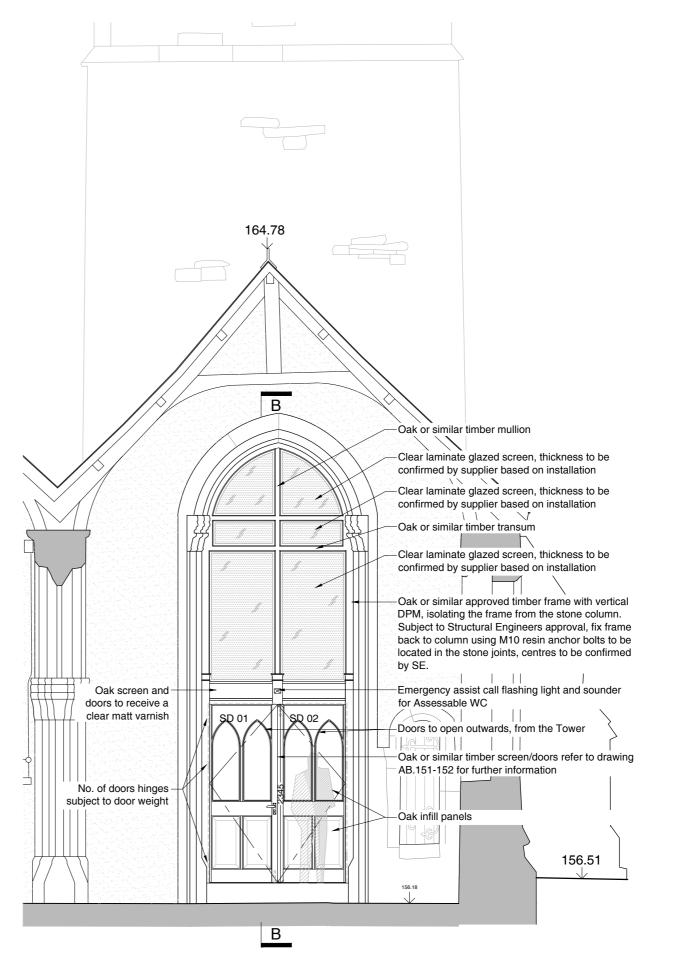

Proposed Glazed and Timber Screen
Scale 1:50

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For Comment

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Client

St Sampson PCC

Project Name

St Sampson Church Re-Ordering

Acces.WC, Screen, Kitchenette, Chapel

Drawin

Proposed Timber and Glazed Screen
Existing and Proposed Elevations

Scale 1:50 @ A3

Drawn by Date
MS August 2022
Checked by

Project No. Drawing No Revision

August 2022


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Case Study 2, St Petroc, Egloshayle





St Petroc, Egloshayle






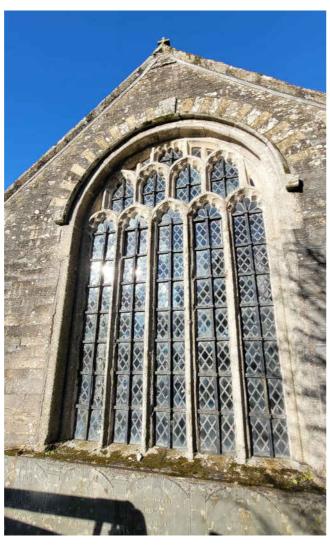

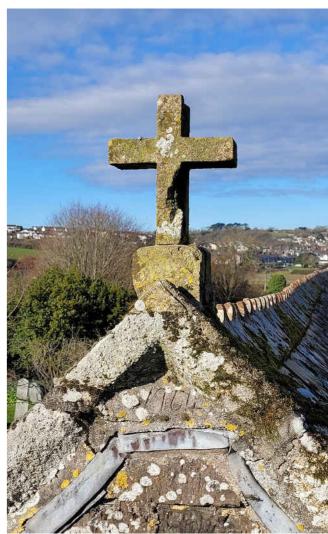

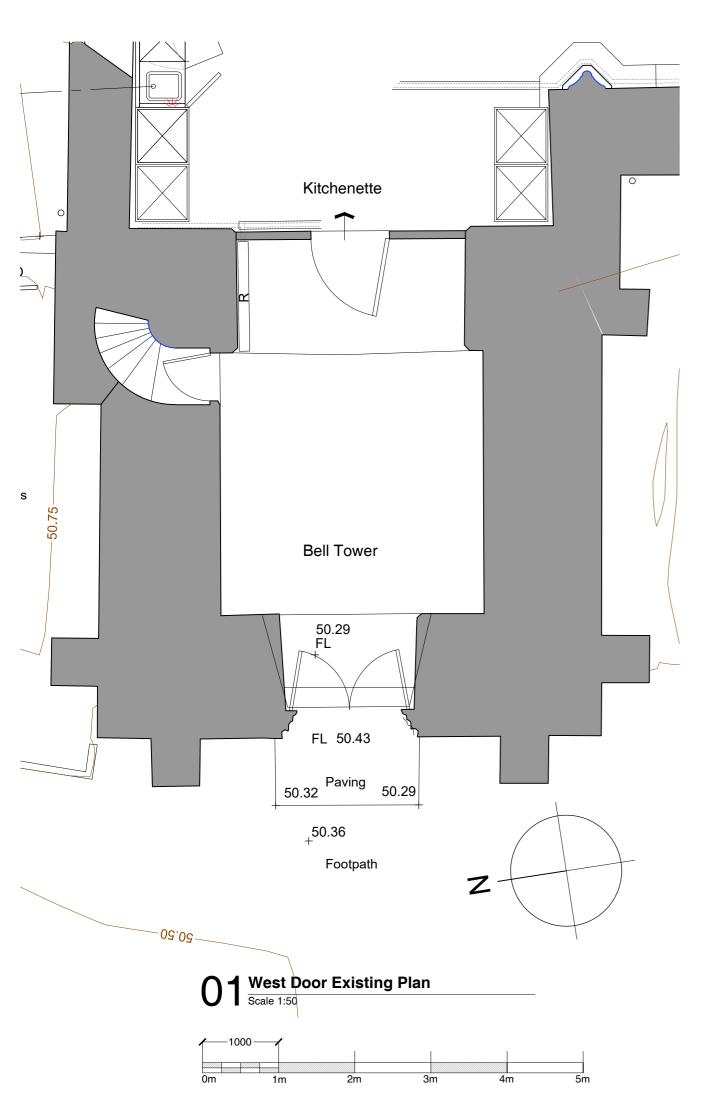

Dislodged stone behind door leaf to be pushed back in place and secured with stainless steel dowel pin repair

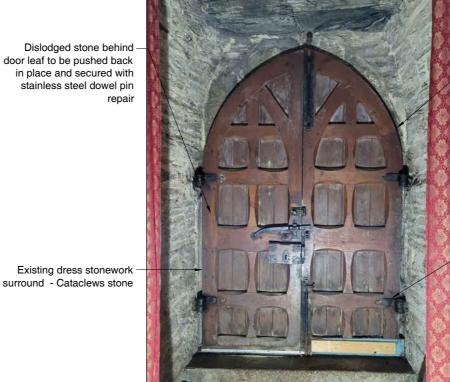

Rake out all cement mortar pointing and repoint with Cornerstone Drymix mortar mix, 3:1, NHL 2.5 and CLD 28 coarse

Stainless steel dowel pin repair to cracked stone behind door leaf


02 West Door Existing Internal Elevation
Scale 1:50

Stainless steel dowel pin repair to cracked stone

Surface repair to damaged stonework with Saint Astier St.One surface repair mortar, colour matched in accordance with data sheet

Grout repair to fine crack to figurehead with Saint Astier St. One surface repair mortar, colour matched in accordance with data sheet Surface repair to damaged stonework with Saint Astier St.One surface repair mortar, colour matched in accordance with data sheet

Stainless steel dowel pin repair to cracked stone

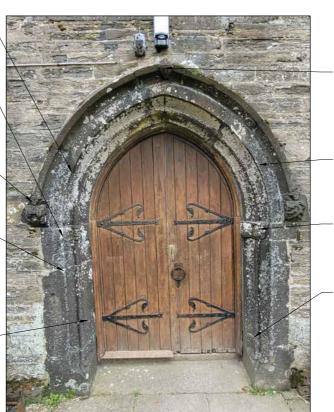

Surface repair to damaged stonework with Saint Astier St.One surface repair mortar, colour matched in accordance with data sheet

Existing dress stonework surround - Cataclews stone

-Dislodged stone to be pushed back in place and secured with stainless steel dowel pin repair

Rake out all cement mortar pointing and repoint with Cornerstone Drymix mortar mix, 3:1, NHL 2.5 and CLD 28 coarse

West Door Existing External Elevation

Scale 1:50

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THIS DRAWING MUST BE READ IN CONJUNCTION WITH OTHER ARCHITECT'S, CONSULTANT'S, SUB-CONTRACTOR'S AND SPECIALIST DRAWINGS.

ALL DIMENSIONS ARE IN MILLIMETRES UNLESS STATED OTHERWISE.

ALL DIMENSIONS ARE TO BE VERIFIED ON SITE AND CONFIRMED, BY THE CONTRACTOR, BEFORE COMMENCEMENT OF CONSTRUCTION.

IF THIS DRAWING EXCEEDS THE QUANTITIES TAKEN, IN ANY WAY, THE ARCHITECTS ARE TO BE INFORMED BEFORE THE WORK IS PUT IN HAND.

Re	v Date	Revision	Ву	Chk
	28/03/23 05/04/23	Updated following site visit Notes updated	GE GE	ST ST

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Client

St Petroc PCC

Project Name

St Petroc, Egloshayle

Drawing

Project No.


West Door Stonework Repairs Plan & Images

1:50 @ A3 Drawn by Date March 2023 Checked by March 2023


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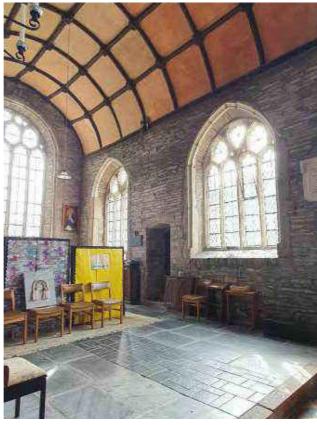
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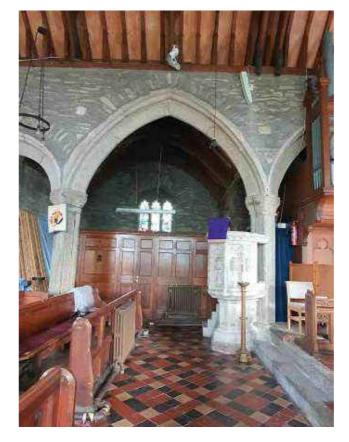
Revision В




Site Photos

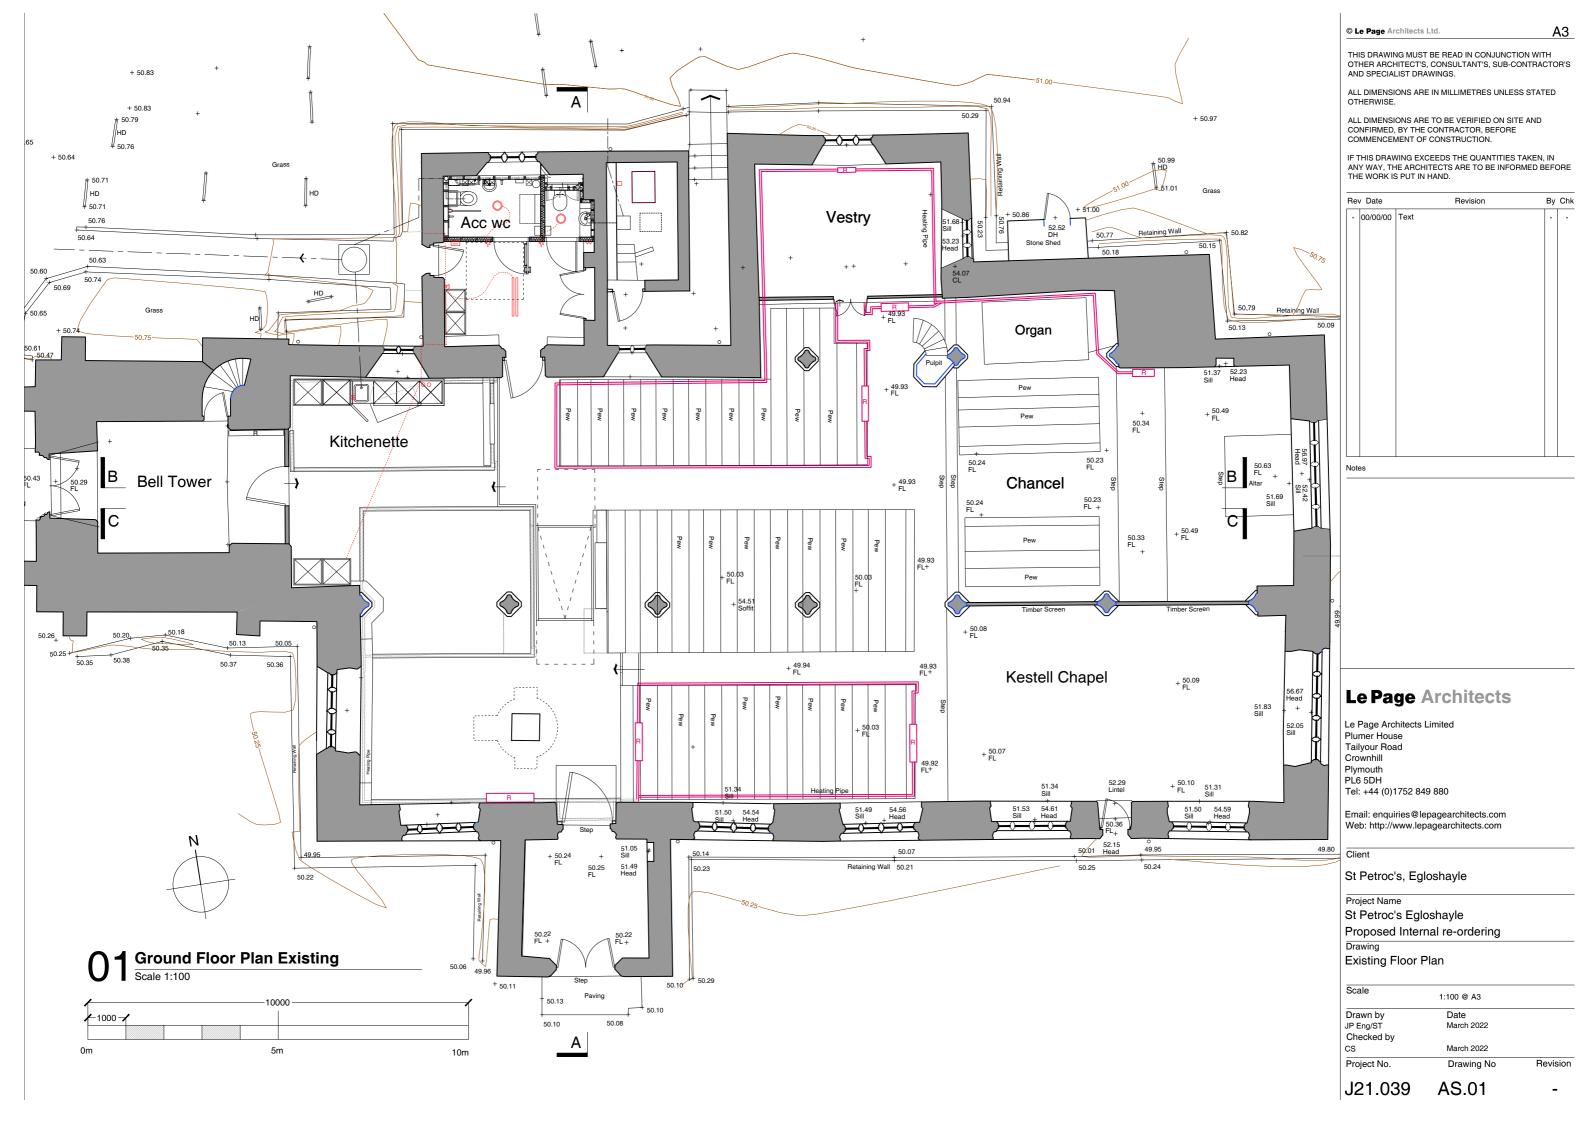





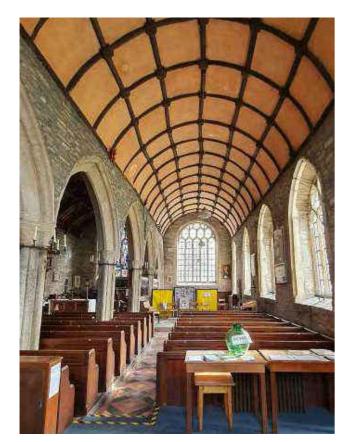



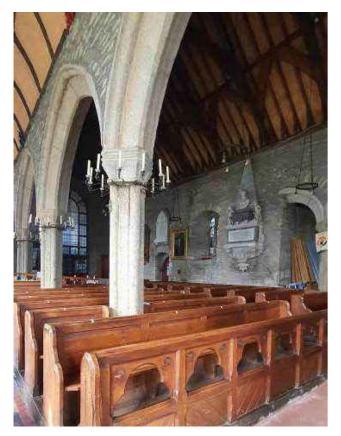

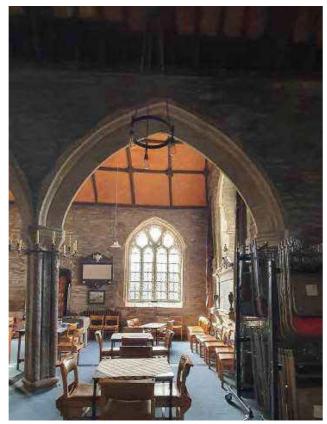

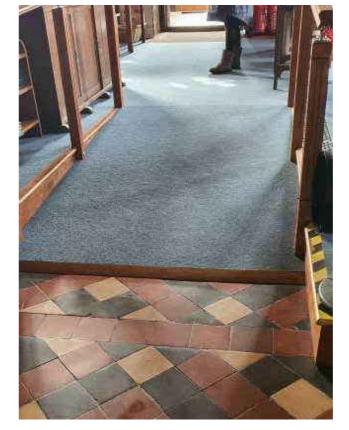



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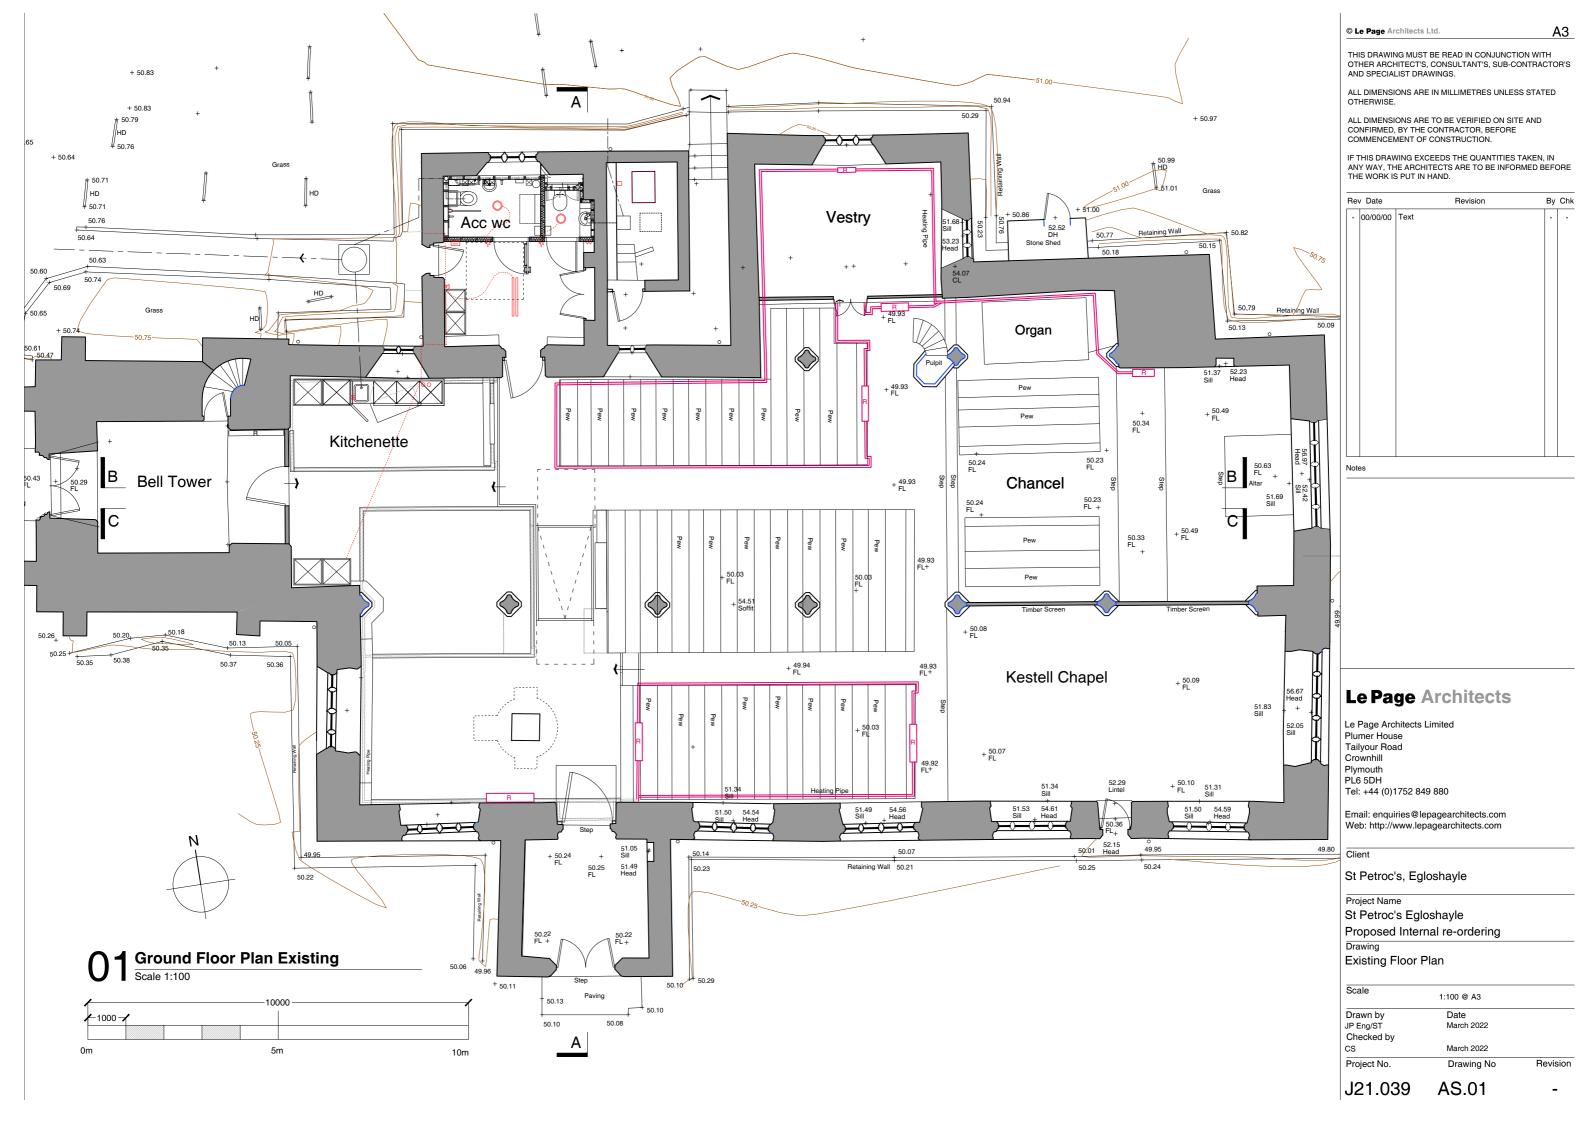
St Petroc, ReOrdering


Brief

- A dedicated worship space and an area for guiet prayer.
- A café / kitchen area
- A warm, environmentally sustainable church
- A church which can be used for a variety of uses by different sectors of the community
- A church that is welcoming, attractive and flexible to use

Proposals

- A new kitchen will be provided in the tower to provide a bigger, spacious area easily located away. This also expands the catering capacity.
- The existing door and window panel to the tower will be retained and converted to bi-fold doors. This gives the option of opening up the kitchen.
- The Ringing Chamber will be relocated to a mezzanine level above the kitchen. A platform lift will be provided to the mezzanine level.
- Raising the internal floor level throughout the church. This will provide space to install under floor heating with minimal excavation. Where floor levels are raised, existing floor finishes such as polychromatic floor tiling will be carefully removed and relaid to the new floor level.
- The church is made more accessible by providing level access throughout. Level access is provided from the Porch into the church and continues through to the Vestry, Chancel and Kestell Chapel. An access ramp is also provided from the North Aisle to the accessible toilet.
- The vestry screen is relocated to enlarge the Vestry which will be used as a Parish Office



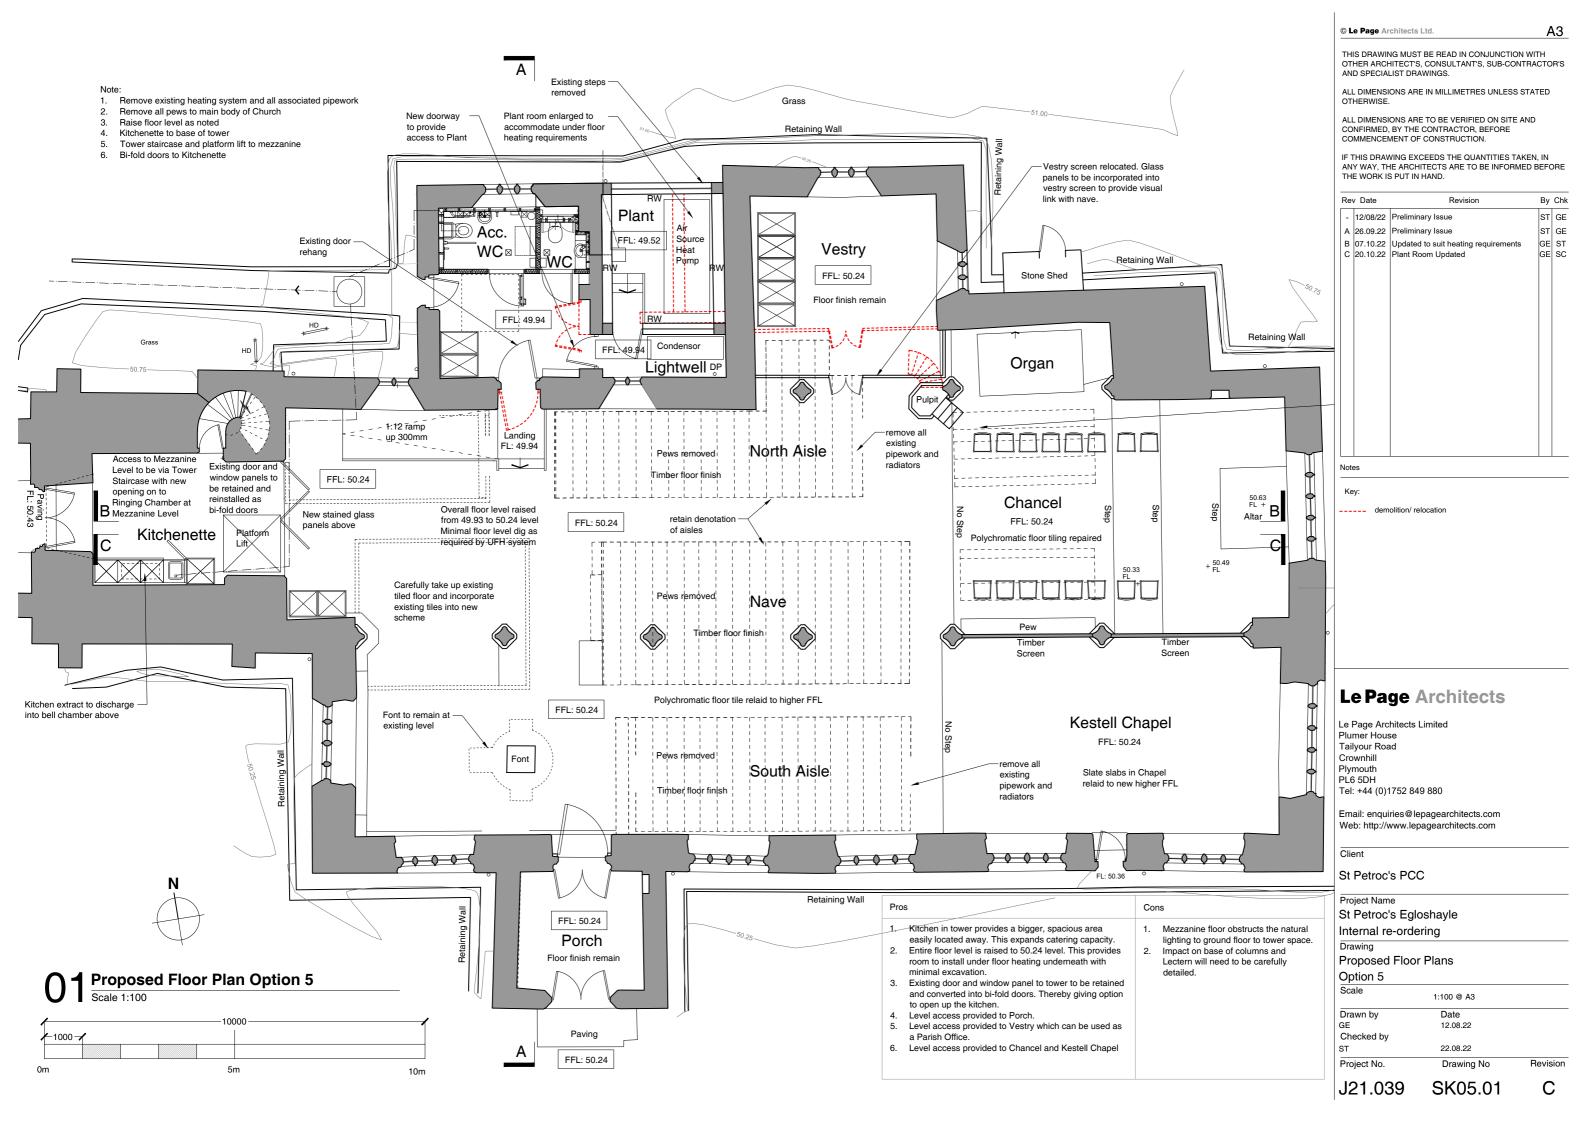

St Petroc, Interior, Heating

Existing heating system

50kW gas fired boiler in plantroom serving cast iron pipework and column radiators. Electric warm heaters to toilets and bell tower. Electric panel heaters to upgraded toilets. Gas boilers now removed.

Options

- 1. New gas fired boiler(s) feeding two separate circuits. Traditional radiator circuit for background heating + fan convector circuit to provide rapid warm up.
- 2. Underfloor heating (UFH) linked to an air source heat pump (ASHP). Would work well where floor levels are being raised. Where necessary, radiators or fan convectors can be added.
- 3. Combination of the two above, ie underfloor heating linked to gas boiler(s).

Wider Energy Use

Most lighting is already fitted with LED lamps, with the exception of strip lights and floodlighting.

Limited small power, hot water generation and drainage pump.

Issues to be Considered

Will need to review load assessment for electrical supply to accommodate the change in fuel source.

Noise, location and visual impact

Consider electric heating as part of a hybrid solution

Consider convector radiators or fan convectors for tower mezzanine and where floors levels are not being adjusted

PV panels can help reduce operational costs and associated emissions

Installation Costs

Running Costs (based on 2019 invoicing and age of boiler)

Fabric protection

Boiler Back Up

Application for formal advice with DAC and Pre App with Planning Authority

Summary

For relatively low use with no fabric protection, gas fired boiler is best option from a capital and operational cost and the lowest carbon emissions.

With fabric protection, operational costs and associated emissions increase significantly for gas fired boiler but this still provides the best capital and operational costs.

UFH lined to ASHP has the highest capital and operational costs, but offers lowest carbon emissions. It will also become more sustainable over time as the Mains Electricity Grid emissions rates improve.

Any Questions?



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